

TOWNHOUSE SCHEDULE

 TYPE
 COUNT

 3B5P
 29

 356P
 2

 31 TOTAL

Refer to drawing 131106 for total areas per townhouse.

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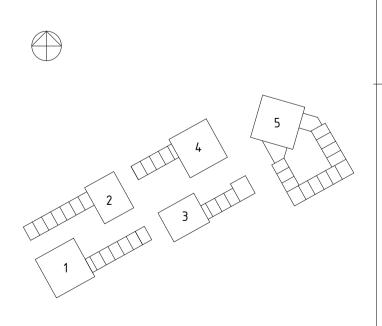
ALL HEIGHTS ARE EXPRESSED AS AOD (ABOVE ORDNANCE DATUM NEWLYN).

ALL DIMENSIONS ARE PRELIMINARY.

1 Updated Planning 19/08/2020
REV. REVISION DESCRIPTION DATE S

Planning Submission

GWP2 Townhouses & hub





Be**First**

PROJECT ARCHITECT
Paddy Perring

PROJECT NO. 9157050100 DRAWN BY HT

DATE APPROVED BY Linda Thiel

TOWNHOLISES

TOWNHOUSES AREA PLANS (NIA) APARTMENTS

NUMBER BF0144-WAB-XX-XX-DR-A-131401 **1**

1:800 (A3) SCALE 1:400 (A1)

METRE
0 2 4 10 20 30 40



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Elevations key:

- Vertical stretcher course brick
- 2. Horizontal stretcher course projecting
- brick band

 3. Recessed panel between windows
- 4. Metal rainscreen fins
- Meral rainscreen fins
 Full height glazing
- 6. Inset balcony horizontal stretcher course
- projecting brick with metal railing
- 7. Inset balcony metal
- Projecting balcony metal
 Projecting balcony horizontal stretcher
- course brick with metal railing
- 10. Projecting balcony loggia structure
- 1. Loggia structure
- 12. MVHR vent above window exact
- placement tbc
- 13. Recessed rainwater pipe (townhouses)14. Rooftop plant
- 5. Satellite dish
- 16. Metal Juliet balcony with double doors
- (townhouses)
- 17. Horizontal stretcher course brick18. Perforated metal screen with openable
- window behind


Refer to Design & Access Statement (BF0144-WAB-ZZ-ZZ-RP-A-130001) for rendered elevations, detailed callouts and information on brick types.

1 Updated Planning 19/08/2020

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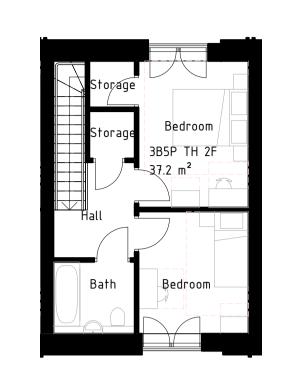
DATE APPROVED BY Linda Thiel


PROJECT ARCHITECT
Paddy Perring


ALL PARCELS

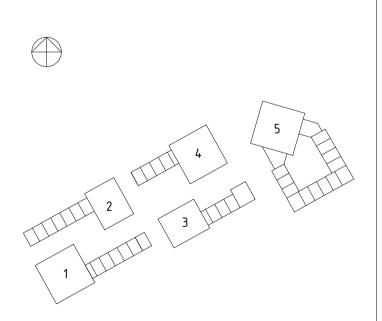1:200 (A3) SCALE 1:100 (A1)

METRE
0 1 2,5 5 7,5 10



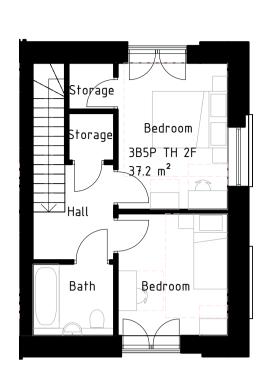

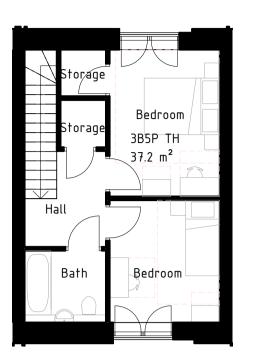





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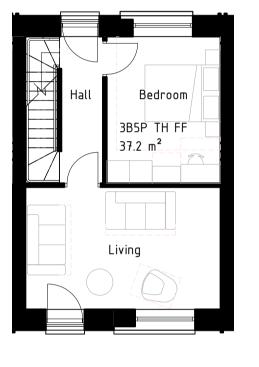
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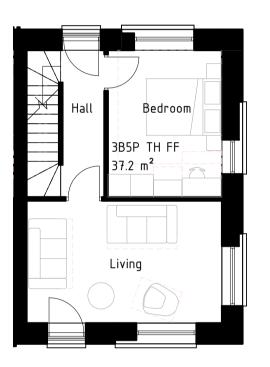
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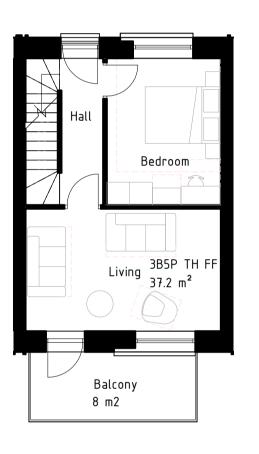
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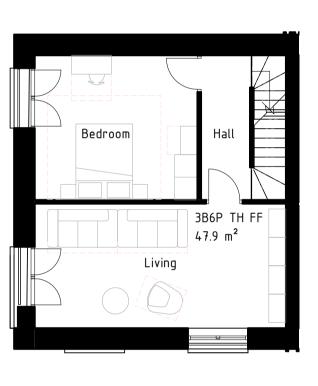
LEVEL 1


LEVEL 2










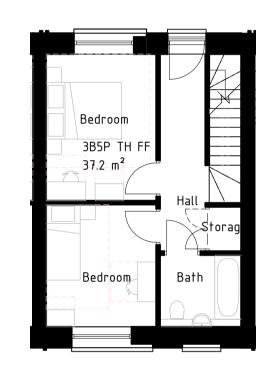


GROUND

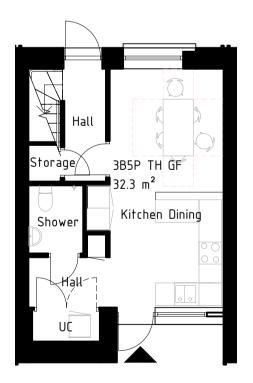


TYPE 1 - 3B5P STANDARD TOWNHOUSE

106.7 m2

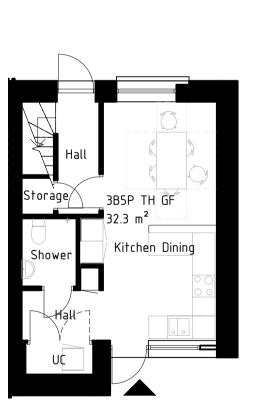


TYPE 2 – 3B5P END HOUSE

106.7 m2

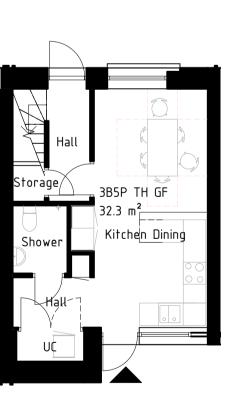

TYPE 3 - 3B5P
STANDARD TOWNOUSE
WITH BALCONY AT
FIRST FLOOR

106.7 m2

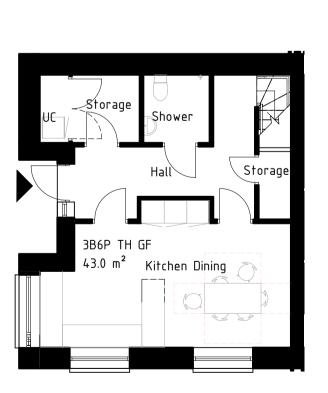


TYPE 4 - 3B6P

CORNER TOWNHOUSE

WITH ROOF TERRACE

(SEE GA'S FOR ROOF PLAN)

138.9 m2 / 141.7 m2

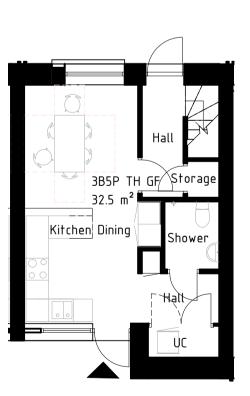


TYPE 5 - 3B5P

STANDARD TOWNHOUSE WITH
LIVING ROOM & BALCONY AT
SECOND FLOOR

106.7 m2



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|---|----------------------------------|----|-----------------|
| 27 Charlotte Rd, Londo www.white.se/en | n EC2A 3PB, United Kingo | om | |

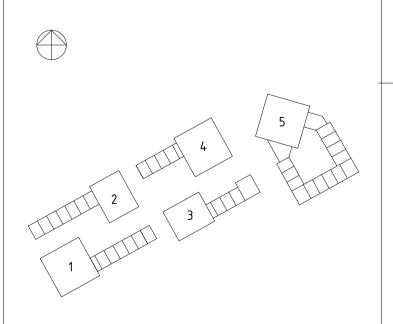PROJECT NO.
9157050100

DRAWN BY
HT
PROJECT ARCHITECT
Paddy Perring


DATE
APPROVED BY
31/07/2020

Linda Thiel

TOWNHOUSE LAYOUT TYPES

SCALE A1 100 BF0144-WAB-XX-XX-DR-A-131106 **1**

1:200 (A3) SCALE 1:100 (A1) METRE 0 1 2,5 5 7,5 10

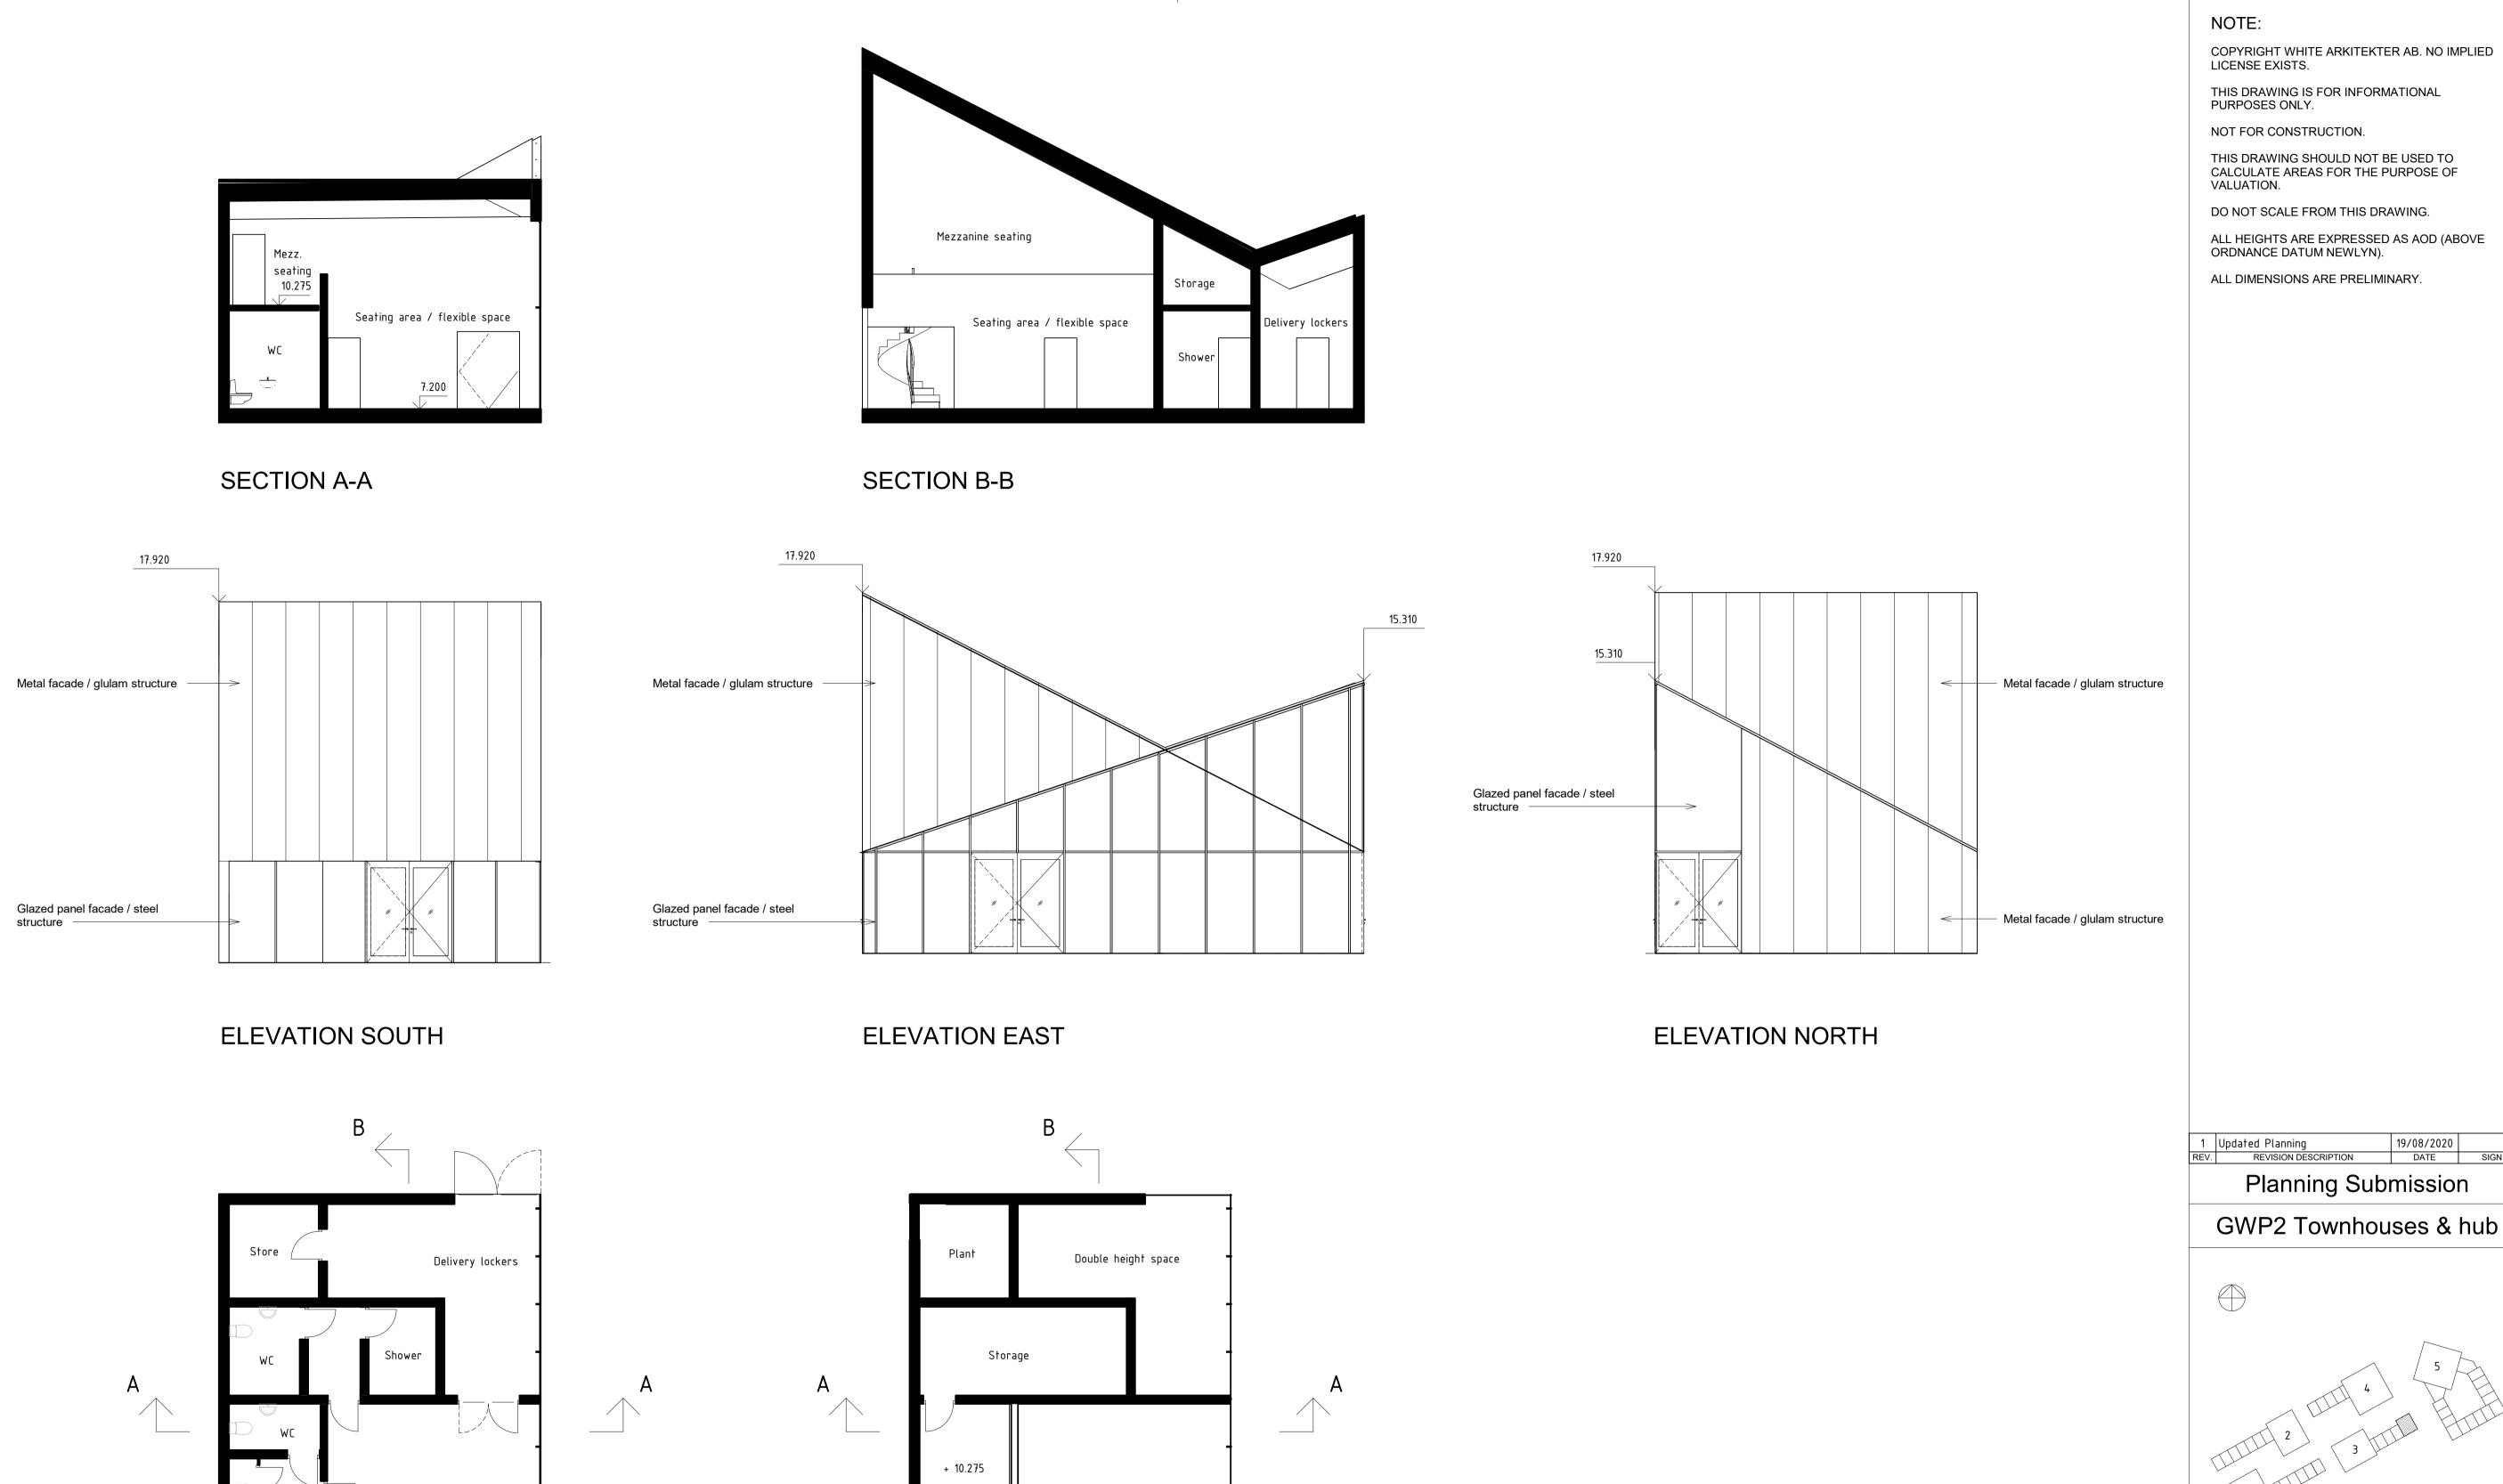

Double height space

GEA 58.9 sqm

LEVEL 1

1:200 SCALE 1:100

0 1 2,5 5


METRE

7,5

Seating area / flexible space

GEA 142.6 sqm

GROUND

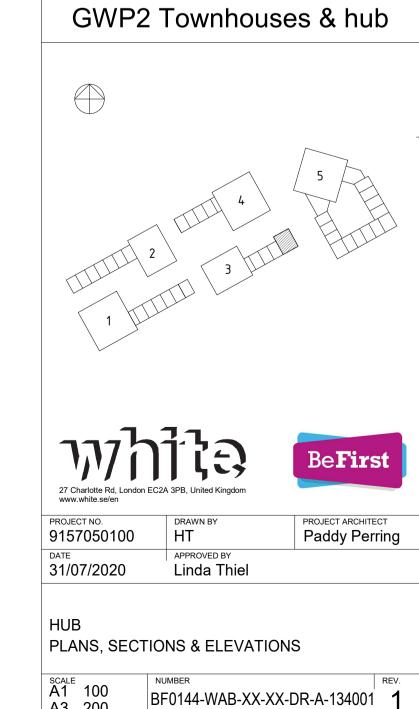

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